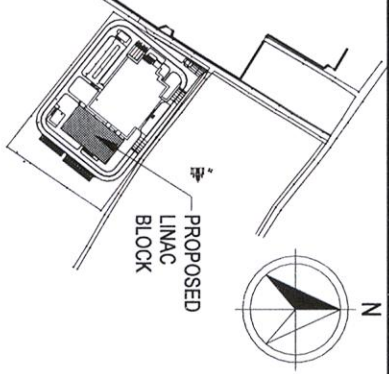


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FLOOR LEVEL	00-SH-XXX	SERIAL NO.	SHAFT TYPE / SHAFT
1XX	PHE		
2XX	HVAC		
3XX	ELECTRICAL		
4XX	ELEV		

#### KEY PLAN SCALE: NTS

#### WALL LEGEND:

- 1250MM THK. BLOCK WALLS UP TO SOFFIT OF THE SLABBEAM.
  - 230MM THK BRICK WORK UP TO SOFFIT OF THE SLABBEAM.
  - 115MM THK BRICK WORK UP TO SOFFIT OF THE SLABBEAM.
  - 75MM THK DRY TO DRY WALL PARTITION FROM TOC to 100mm high TOP OF THE FALSE CEILING.
  - 75MM THK DRY TO WET WALL PARTITION FROM TOC to 100mm high TOP OF THE FALSE CEILING.
  - 200MM THK DRY TO DRY WALL PARTITION FROM TOC to 100mm high TOP OF THE FALSE CEILING.
  - 125MM THK DRY TO DRY WALL PARTITION (FRAIRED) UP TO SOFFIT OF THE SLABBEAM.
  - 125MM THK DRY TO WET WALL PARTITION UP TO SOFFIT OF THE SLABBEAM.
  - 125MM THK DRY TO DRY WALL PARTITION UP TO SOFFIT OF THE SLABBEAM.
- KEY NOTES:**
- 500MM WIDE SUNSHADE PROJECTION ABOVE.
  - 600MM WIDE PLINTH PROTECTION.
  - RAIN WATER DOWN TAKE PIPE.
  - 600MM WIDE COUNTER TO DETAIL.
  - 150MM THK, 150MM HIGH KERB WALL.
  - MAN HOLE REFER STRUCTURAL DRAWING.
  - TRENCH DETAIL REFER STRUCTURAL DRAWING.
  - 900MM WIDE SUNSHADE PROTECTION ABOVE.
  - ELECTRICAL DB LOCATION.
  - COVER FOR SUMP AS PER STRUCTURAL DETAIL.
  - 1000 MM HIGH MS HANDRAIL.
  - 600 MM WIDE SUNSHADE PROJECTION ABOVE.

#### LINAC - GROUND FLOOR - DOOR SCHEDULE

TAG	WIDTH	HEIGHT	COUNT
-----	-------	--------	-------

AD14b	2000	2400	3
AD14c	2000	2400	2
FD06	1200	2100	1
FD09	900	2100	2
LD01	2000	2300	2
LD02	1500	2300	1
LD03a	1500	2100	1
WD06a	2000	2300	2
WD09a	1500	2100	3
WD11a	1000	2100	2

#### LINAC - GROUND FLOOR - DOOR SCHEDULE

TAG	WIDTH	HEIGHT	COUNT
WD17	850	2100	9
WD17a	850	2100	1
WD19	1050	2100	2
WD19a	1050	2100	1
WD19b	1050	2300	2

#### FLOOR - ROOM LEVEL - ROOM TYPE

#### ROOM TAG KEYNOTE:

- T - TOILET
- L - LIFT LOTS
- ST - STAIRCASE
- R - ROOMS
- S - SERVICES

TAG	DESCRIPTION	LENGTH	WIDTH
AW01	ELECTRICAL SHAFT	300	300
LD01	1200	1200	900
LD02	1200	1200	900

#### SUNKEN LEGEND:

200MM SUNKEN FROM FFL


#### LEGEND:

- FRL FINISHED ROAD LEVEL
- FGL FORMED GROUND LEVEL
- FFL FINISHED FLOOR LEVEL
- FEA FIRE EQUIPMENT AREA
- TOC TOP OF CONCRETE
- LVL LEVEL
- TOI TOILET
- ELEV EXTRA LOW VOLTAGE
- PHE PUBLIC HEALTH ENGINEERING
- HVAC HEATING VENTILATION AIR CONDITIONING
- AHU AIR HANDLING UNIT
- LD LEAD LINED DOOR
| AL ALUMINIUM LOUVER | AW ALUMINIUM WINDOW | AD ALUMINIUM DOOR | WD WOODEN DOOR |
| FD FIRE DOOR | FD FIRE DOOR | FD FIRE DOOR | FD FIRE DOOR |
| RSO RADIATION SAFETY OFFICER | RSO RADIATION SAFETY OFFICER | RSO RADIATION SAFETY OFFICER | RSO RADIATION SAFETY OFFICER |
| TPS TREATMENT PLANNING STATION | TPS TREATMENT PLANNING STATION | TPS TREATMENT PLANNING STATION | TPS TREATMENT PLANNING STATION |
| CT COMPUTER TOMOGRAPHY | CT COMPUTER TOMOGRAPHY | CT COMPUTER TOMOGRAPHY | CT COMPUTER TOMOGRAPHY |
| FPL FINISHED PAYER BLOCK | FPL FINISHED PAYER BLOCK | FPL FINISHED PAYER BLOCK | FPL FINISHED PAYER BLOCK |
| NS NURSE STATION | NS NURSE STATION | NS NURSE STATION | NS NURSE STATION |

#### CUTOUT LEGEND:

- FLOOR CUTOUT
- ROOF CUTOUT

#### NORTH POINT:

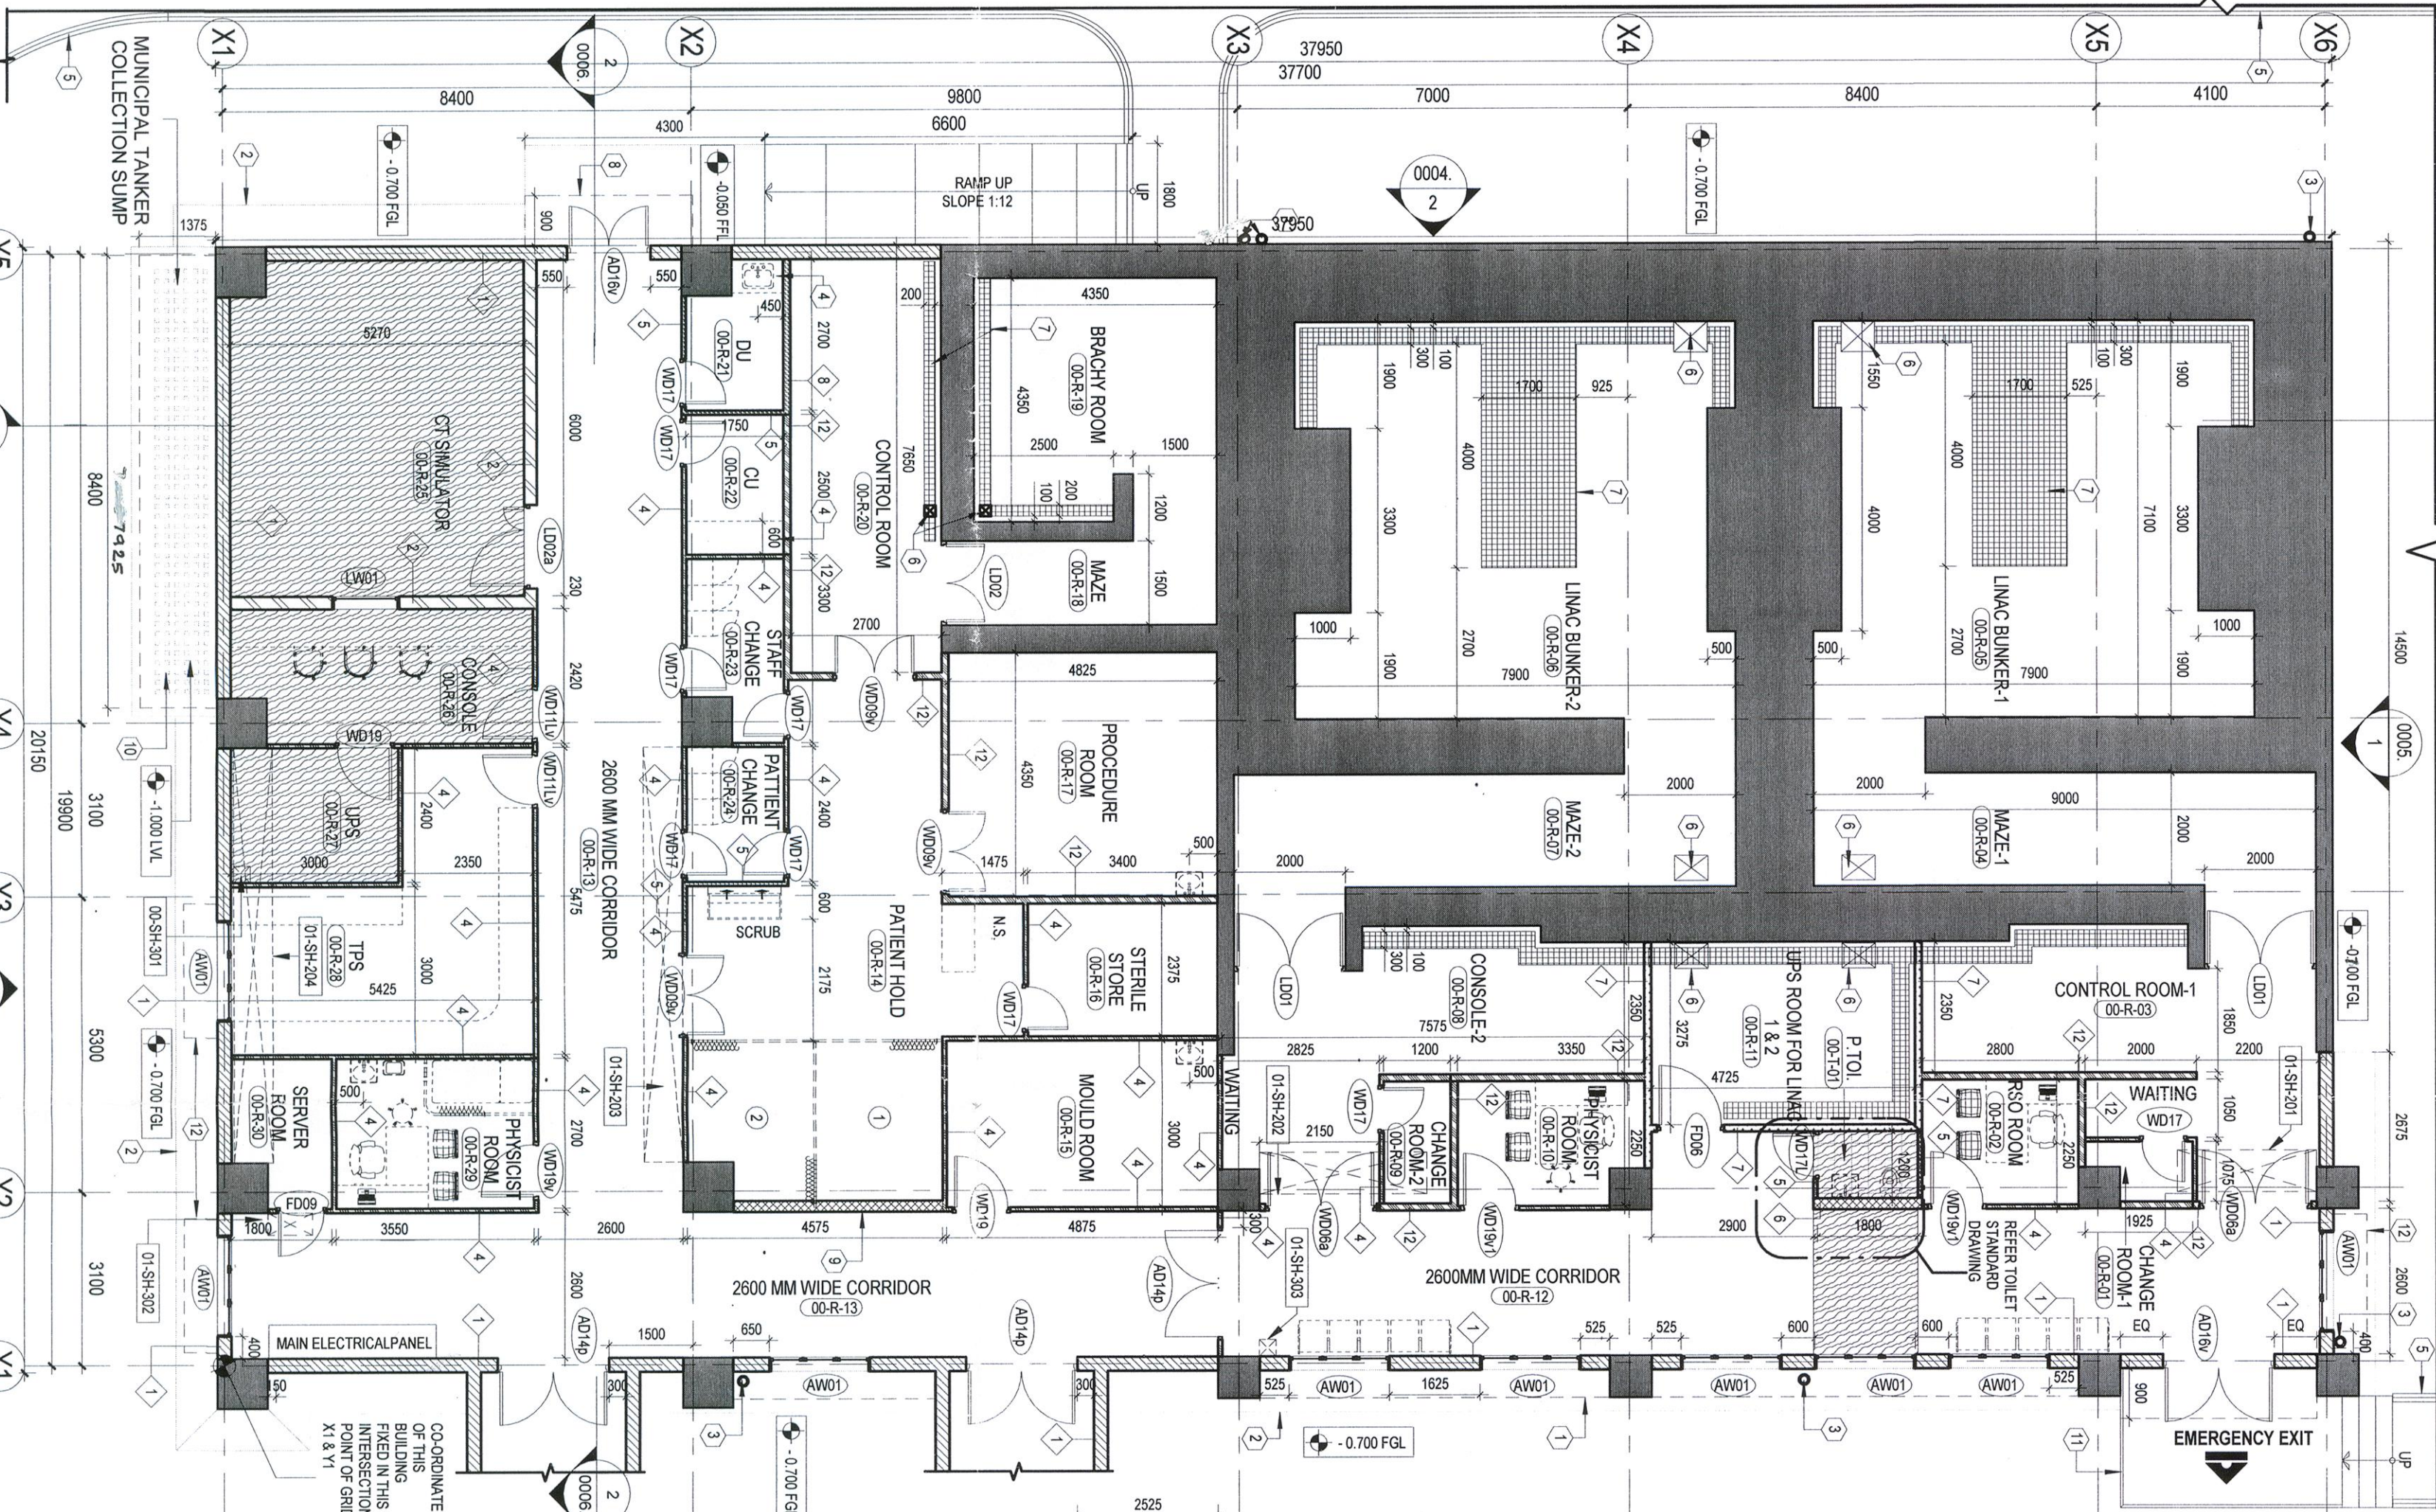

#### GROUND FLOOR PLAN

SCALE - 1 : 100

#### GENERAL NOTES:

01. ALL DIMENSIONS ARE IN MILLIMETERS & LEVELS IN METERS.
02. THIS DRAWING SHOULD BE READ IN CONJUNCTION WITH THE FOLLOWING DRAWINGS: 019035-A-HP-18-WD-0002 TO 0005.
03. FOR JOINERY, STAIRCASE, RAMP DETAILS, LIFTS, TOILETS, WALL SECTIONS, FLOORING PATTERN DETAILS & FALSE CEILING DETAILS REFER SEPARATE DRAWINGS.
04. FOR STRUCTURAL, PUBLIC HEALTH ENGINEERING, HVAC, ELECTRICAL, AND FIRE FIGHTING DETAILS REFER APPROPRIATE SEPARATE DRAWINGS.
05. ALL EXTERNAL WALLS SHOULD BE BUILT UP TO SOFFIT OF BEAM OR CEILING.
06. ANY DISCREPANCIES NOTICED IN THIS DRAWING SHOULD BE BROUGHT TO EPRS NOTICE IMMEDIATELY.
07. ALL ROOF SLAB CUTOUTS INDICATED IN THIS DRAWING ARE TENTATIVE. REFER STRUCTURAL DRAWINGS FOR EXACT LOCATION.
08. +0.000 FFL REFERS TO +55.500 LEVEL AT SITE.
09. FURNITURE SHOWN IF ANY ARE INDICATIVE ONLY AND NOT IN L&T SCOPE.

#### CLIENT SIGNATURE:

REV/NO	DESCRIPTION	DESIGNED	DRAWN	CHECKED	APPROVED
0	RELEASED AS GOOD FOR CONSTRUCTION	ARCH 30.01.20	TJR 30.01.20	TI 31.01.20	JA 31.01.20

CHECKED BY	SIGN	DATE	CHECKED BY	SIGN	DATE
ARCHITECTURE		31.1.20	HVAC		31.1.20
CIVIL & STRUCTURAL		31.1.20	FPS		31.1.20
ELECTRICAL		31.1.20	PIPING		31.1.20
ELEV SYSTEM		31.1.20	PHE		31.1.20



ASSAM CANCER CARE FOUNDATION

PROJECT: Proposed Cancer Centre At 18 locations in Assam For Assam Cancer Care Foundation & M/s. Tria Trusts

CONSULTANT: Engineering Design and Research Center (EDRC), L&T Construction - Buildings & Factories.

CONCEPT: Engineering Design and Research Center (EDRC), L&T Construction - Buildings & Factories.

ARCHITECT: L&T Construction - Buildings & Factories.

SUPPLIER/CONTRACTOR: Larsen & Toubro Limited Construction, Buildings & Factories

JOB No.: 019035

TITLE: LINAC BLOCK

DRAWING No. 019035 - A - HP - 18 - WD - 0001.

RELEASED FOR: ☐ PRELIMINARY ☐ TENDER ☐ INFORMATION ☐ APPROVAL ☒ CONSTRUCTION



L&T Construction

Buildings & Factories

CONSULTANT: Engineering Design and Research Center (EDRC), L&T Construction - Buildings & Factories.

CONCEPT: Engineering Design and Research Center (EDRC), L&T Construction - Buildings & Factories.

ARCHITECT: L&T Construction - Buildings & Factories.

SUPPLIER/CONTRACTOR: Larsen & Toubro Limited Construction, Buildings & Factories

JOB No.: 019035

TITLE: LINAC BLOCK

DRAWING No. 019035 - A - HP - 18 - WD - 0001.

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